
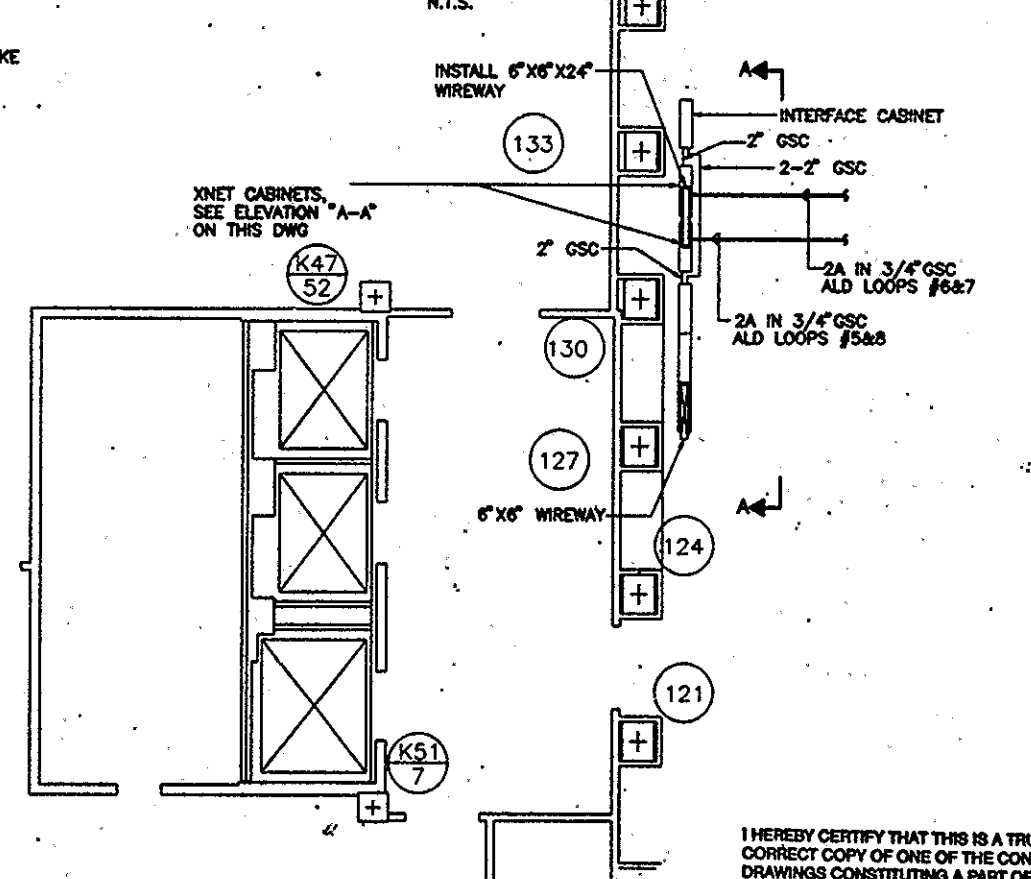


1 WTC B6 LEVEL MER PLAN

ELEV. 242'-0"

SCALE IN FEET

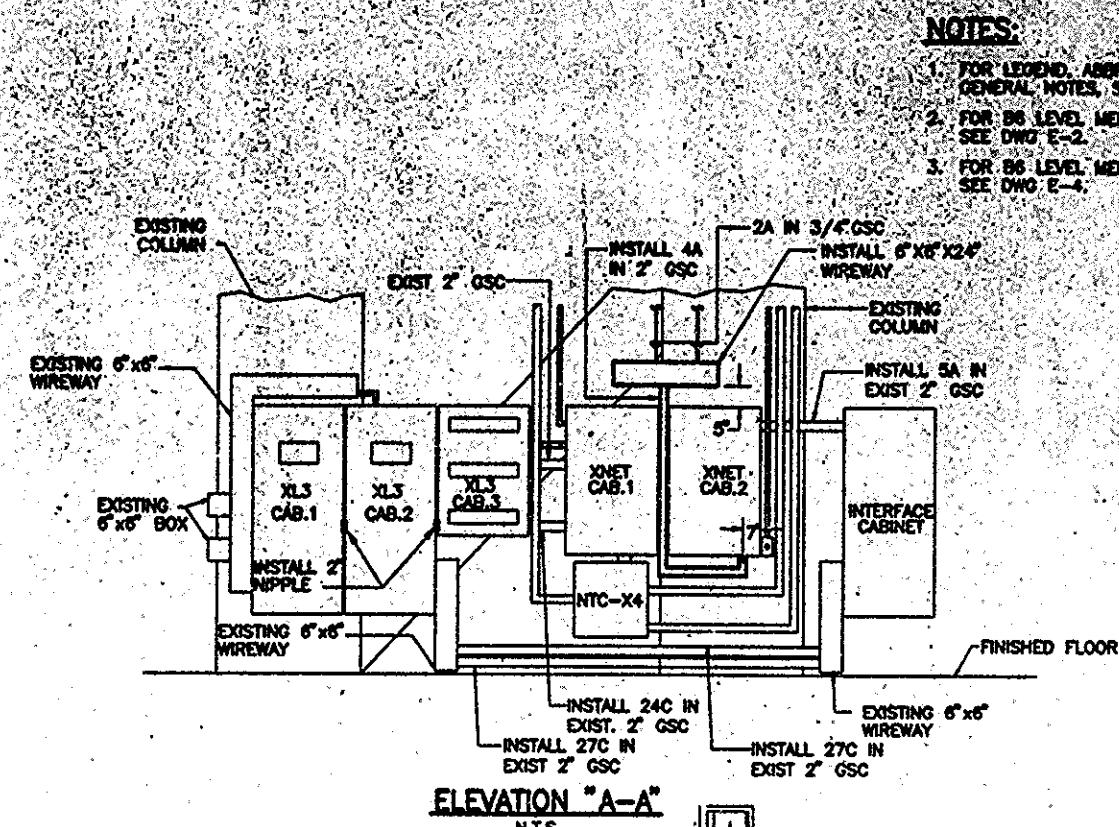


SCALE IN FEET

NOTES

1. FOR LEGEND, ABBREVIATIONS & GENERAL NOTES, SEE DWG E-1.
2. FOR B6 LEVEL MER RISER DIAGRAM, SEE DWG E-2.
3. FOR B6 LEVEL MER REMOVAL PLAN, SEE DWG E-4.

I HEREBY CERTIFY THAT THIS IS A TRUE AND CORRECT COPY OF ONE OF THE CONTRACT DRAWINGS CONSTITUTING A PART OF CONTRACT NO. WTC-861082 IN THE FORM IN WHICH SAID DRAWINGS EXISTED AT THE TIME THE SAID CONTRACT WAS EXECUTED BY THE PARTIES.

DATE 11/00 [Signature]
 DATE 11/00 [Signature]
 CONTRACT ENGINEER
 ENGINEERING PROGRAM MGR.

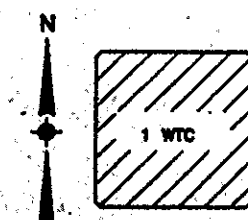

KEY PLAN

No. Date Revision Approved			
Engineering Department			
Design Division			
The World Trade Center			
Title			
FIRE ALARM SYSTEM PHASE II XL3 CONVERSION ELECTRICAL 1 WTC B6 LEVEL MER PLAN			
This drawing subject to conditions in contract. All inventions, ideas, designs and methods herein are reserved to Port Authority and may not be used without its written consent.			
ROYZMAN FELDMAN	ROYZMAN FELDMAN	A.S. A.S.	A.S. A.S.
Designed by	Drawn by	Checked by	Approved by
Date 5-20-99		Scale AS NOTED	
Contract Number		Drawing Number	
WTC-861082		E-3	